Proposed Alterations & Additions HI NOON SKI CLUB 12 BANJO DRIVE THREDBO NSW 2625

PRACTICAL ENGINEERING SOLUTIONS P/L



STRUCTURAL DRAWING LIST

SHEET NO	TITLE
S01	COVER
S02	SPECIFICATIONS
S03	FOOTING, ACCESS PATH & FLOOR PLAN
S04	PATH LONG SECTION
S05	FRAMING PLAN
S06	SECTIONS

PRACTICAL ENGINEERING SOLUTIONS P/L

ABN 67 157 931 069
Structural &
Project Management ENGINEERS

46 Egan Street Cooma NSW 2630

i: 0402 15 22 16

office@practicalengineers.com.au

Drawing Name:

Proposed Alterations & Additions
HI NOON SKI CLUB
12 BANJO DRIVE THREDBO NSW
2625

Client:

HI NOON SKI CLUB

Structural Sheet No. S01 of 6

 Scale:
 NTS

 Date:
 15.07.2024

 Drawing No:
 20230727A

COVER PAGE

Sheet Size:A3Designed:O BoaruDrawn:A SferleChecked:O Boaru

Approved:



Ovi Boaru MIEAust CPEng

]	ISSUE DATE AMENDMENT INITIA				
	V1	08.08.24	FOOTPATH		ОВ

This document is Copyright and shall not be copied without written approval, nor shall it be used except for the Development and the Site Specified.

All workmanship and materials to conform with latest edition of the Building Code of Australia and relevant Australian Standards.

The contractor is to confirm all dimensions prior to commencing any works on site.

NOTES:

- 1. All workmanship and materials to conform with the latest edition of the building code of Australia and relevant Australian standards.
- 2. It is not implied or guaranteed that all structural designs and details shown in these plans are complete. The scope of the work has been determined by the Engineer based on the information supplied by the client or the clients consultants. The Engineer will provide further designs if required, but is not responsible for any associated cost where design details have not been specifically requested.
- 3. All dimensions on these plans should be checked on site by the builder and verified using Architectural plans and other contract documents. Discrepancies to be referred to the Architect or Engineer.
- 4. DO NOT SCALE FROM THESE DRAWINGS
- 5. The structural details shown in these plans are applicable to the Architectural plans and building elements by TZ DESIGN Architect indicated therein:

Plans No. - 353 revision E

Plan date - 09.01.23

Roof Structure -

Wall Structure -

Floor Structure - BEARERS & JOISTS

- 6. Reference to UNO = Unless Noted Otherwise & NA = Not Applicable.
- 7. Handrail construction to BCA requirements. NA
- 8. Where disturbed existing building must have bracing and tie-down investigated by the builder and referred to the Engineer for compliance checking.

SITE CONDITIONS:

1. Stability/Vegetation -

NA NA

2. Drainage -

NA

3. Soil Type/profile -

. . . . IDI O -

4. AS2870 - 2011 site classification -

Class 'P' See geotech

report

5. AS4055 - 2012 wind classification N3 40m/s (Vh,u).

6. AS1170.3 - 2003 Ultimate Ground Design 1 / 150 Snow Load AT Thredbo - 9.3 KPa

CONCRETE:

- 1. All concrete works to be in accordance with AS3600 2001
- 2. Concrete strength cover and durability details (refer AS3600)

Footings - 32 MPa Internal Slab Garage -25MPa

External Slab - 40 MPa (or 20MPa if weather proofed, ie tiling)

Beams/Columns - NA

- 3. All reinforcement to be adequately supported on bar chairs in correct positions.
- 4. Concrete to be formed as required by AS3610 and compacted in accordance with AS3600 and AS3610 to achieve specified or relevant density durability and strength.
- 5. All reinforced fabric to be lapped one mesh panel plus 25mm and reinforcement bars lapped 40 bar diameters, UNO.

FOOTINGS:

1. Footings and slabs on ground designs conform with AS 2870-2011.

MASONRY

- 1. All masonry (clay, stone and concrete) to comply with AS3700 2011. masonry code.
- 2. Masonry control joints to AS3700.
- 3. Core fill grout mix for hollow block fill to be 20 MPa.

TIMBER:

- 1. All timber construction to comply with Australian Framing Code AS1684.2 2010.
- 2. Bracing and tie down as shown on These Sheets comply with AS 1684.2-2010.
- 3. For external use, use Class 1 or Class 2 HW or Treated Timbers.

STEEL:

1. All steel construction to comply with AS4100 steel structures code and AISC Connection Details.

PRACTICAL ENGINEERING SOLUTIONS P/L

ABN 67 157 931 069
Structural & Project Management ENGINEERS

46 Egan Street Cooma NSW 2630

M: 0402 15 22 16

office@practicalengineers.com.au

Drawing Name:

Proposed Alterations & Additions HI NOON SKI CLUB 12 BANJO DRIVE THREDBO NSW 2625

Client:

HI NOON SKI CLUB

Structural Sheet No. S02 of 6

 Scale:
 NTS

 Date:
 15.07.2024

 Drawing No:
 12.07.2024

COVER PAGE

Sheet Size:A3Designed:O BoaruDrawn:A SferleChecked:O Boaru

Approved:




1	ISSUE DATE AMENDMENT INITIALS			TALS	
	V1	08.08.24	FOOTPATH		ОВ

This document is Copyright and shall not be copied without written approval, nor shall it be used except for the Development and the Site Specified.

All workmanship and materials to conform with latest edition of the Building Code of Australia and relevant Australian Standards.

The contractor is to confirm all dimensions prior to commencing any works on site.

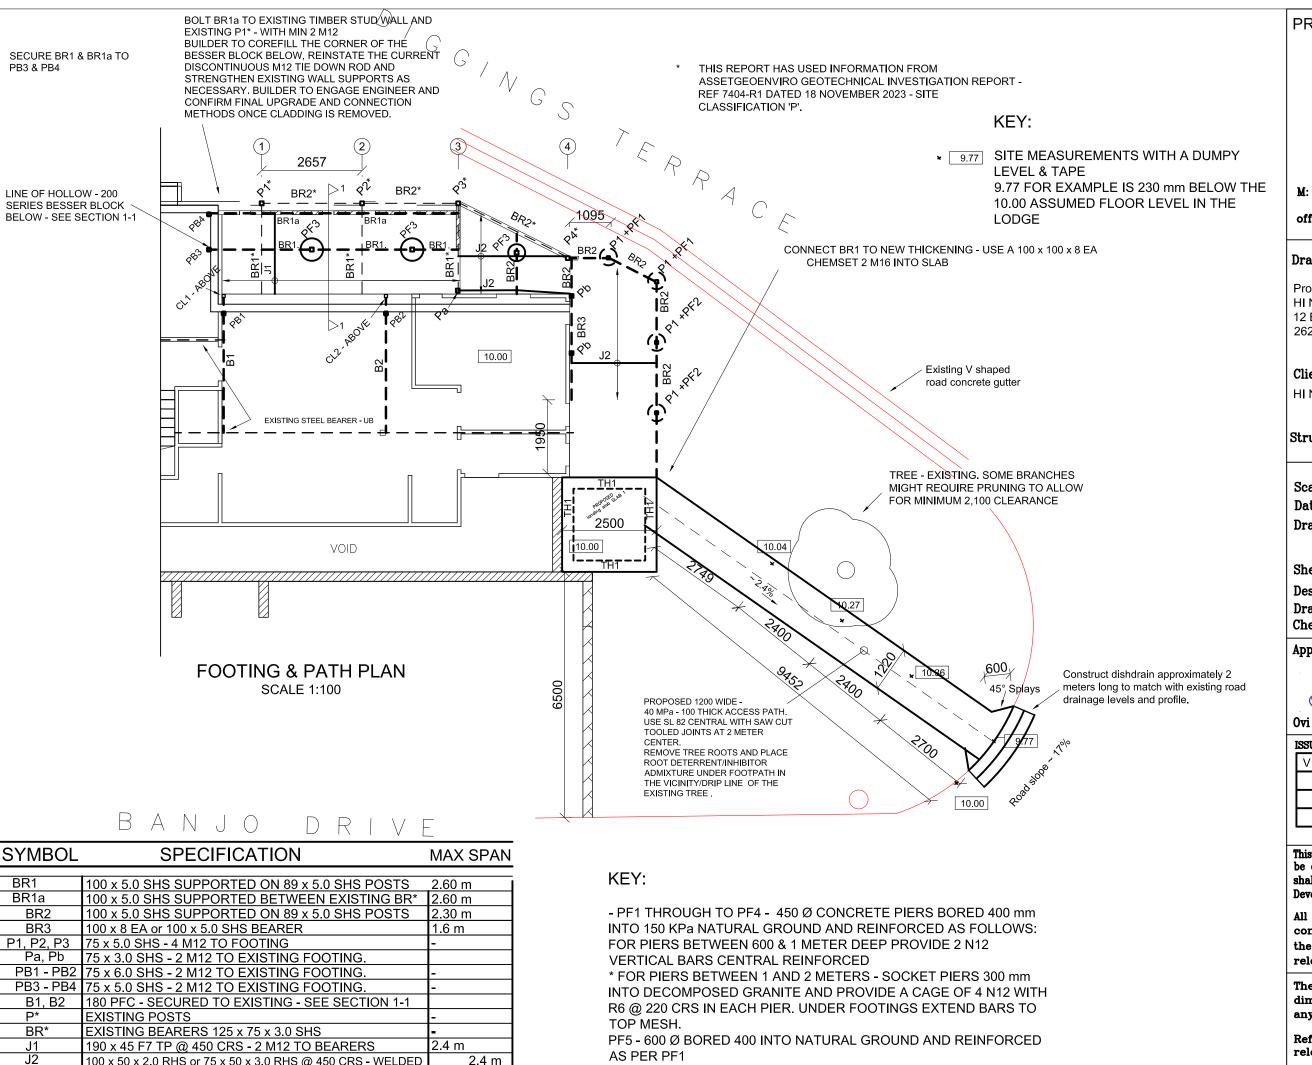

PRACTICAL ENGINEERING SOLUTIONS P/L

ABN 67 157 931 069
Structural & Project Management ENGINEERS

46 Egan Street Cooma NSW 2630

M: 0402 15 22 16

office@practicalengineers.com.au

Drawing Name:

Proposed Alterations & Additions HI NOON SKI CLUB 12 BANJO DRIVE THREDBO NSW 2625

Client:

HI NOON SKI CLUB

Structural Sheet No. S03 of 6

 Scale:
 1:100

 Date:
 15.07.2024

 Drawing No:
 20230727A

 FOOTING AND PATH PLAN

Sheet Size: A3

Designed: O Boaru

Drawn: A Sferle **Checked:** O Boaru

Approved:




Ovi Boaru MIEAust CPEng

ISSUE DATE		AMENDMENT	INI'	TIALS
V1	08.08.24	FOOTPATH		ОВ


This document is Copyright and shall not be copied without written approval, nor shall it be used except for the Development and the Site Specified.


All workmanship and materials to conform with latest edition of the Building Code of Australia and relevant Australian Standards.

The contractor is to confirm all dimensions prior to commencing any works on site.

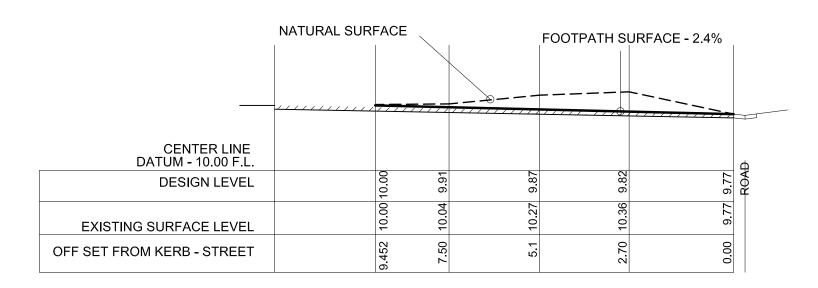

PROPOSED FOOTPATH LONG SECTION ~ 2.1% GRADE SCALE 1:100

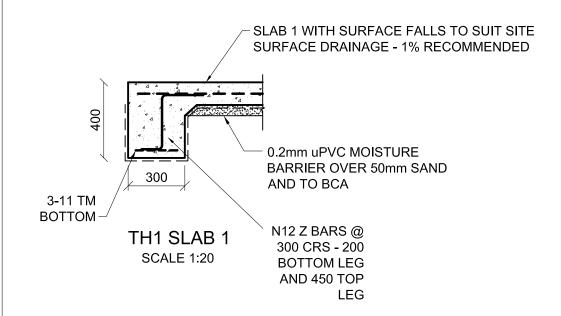

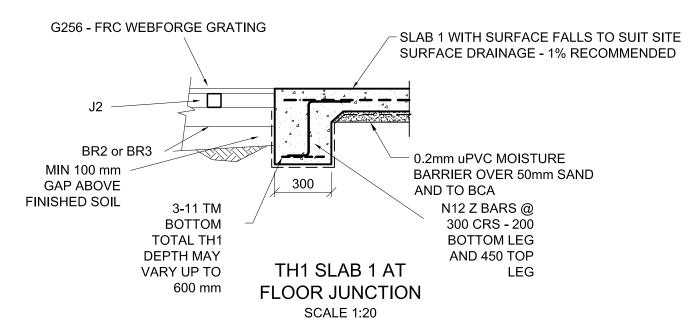

PRACTICAL ENGINEERING SOLUTIONS P/L

ABN 67 157 931 069
Structural &
Project Management ENGINEERS

46 Egan Street Cooma NSW 2630

M: 0402 15 22 16

office@practicalengineers.com.au

Drawing Name:

Proposed Alterations & Additions
HI NOON SKI CLUB
12 BANJO DRIVE THREDBO NSW
2625

Client:

HI NOON SKI CLUB

Structural Sheet No. S04 of 6

Scale: Date:

12:20,1:100 15.07.2024

Drawing No:

20230727A

PATH LONG SECTION

Sheet Size:

A3

Designed:
Drawn:

O Boaru A Sferle O Boaru

Checked:
Approved:




Ovi Boaru MIEAust CPEng

1	ISSUE DATE AMENDMENT INITIALS				
	V1	08.08.24	FOOTPATH		ОВ

This document is Copyright and shall not be copied without written approval, nor shall it be used except for the Development and the Site Specified.

All workmanship and materials to conform with latest edition of the Building Code of Australia and relevant Australian Standards.

The contractor is to confirm all dimensions prior to commencing any works on site.

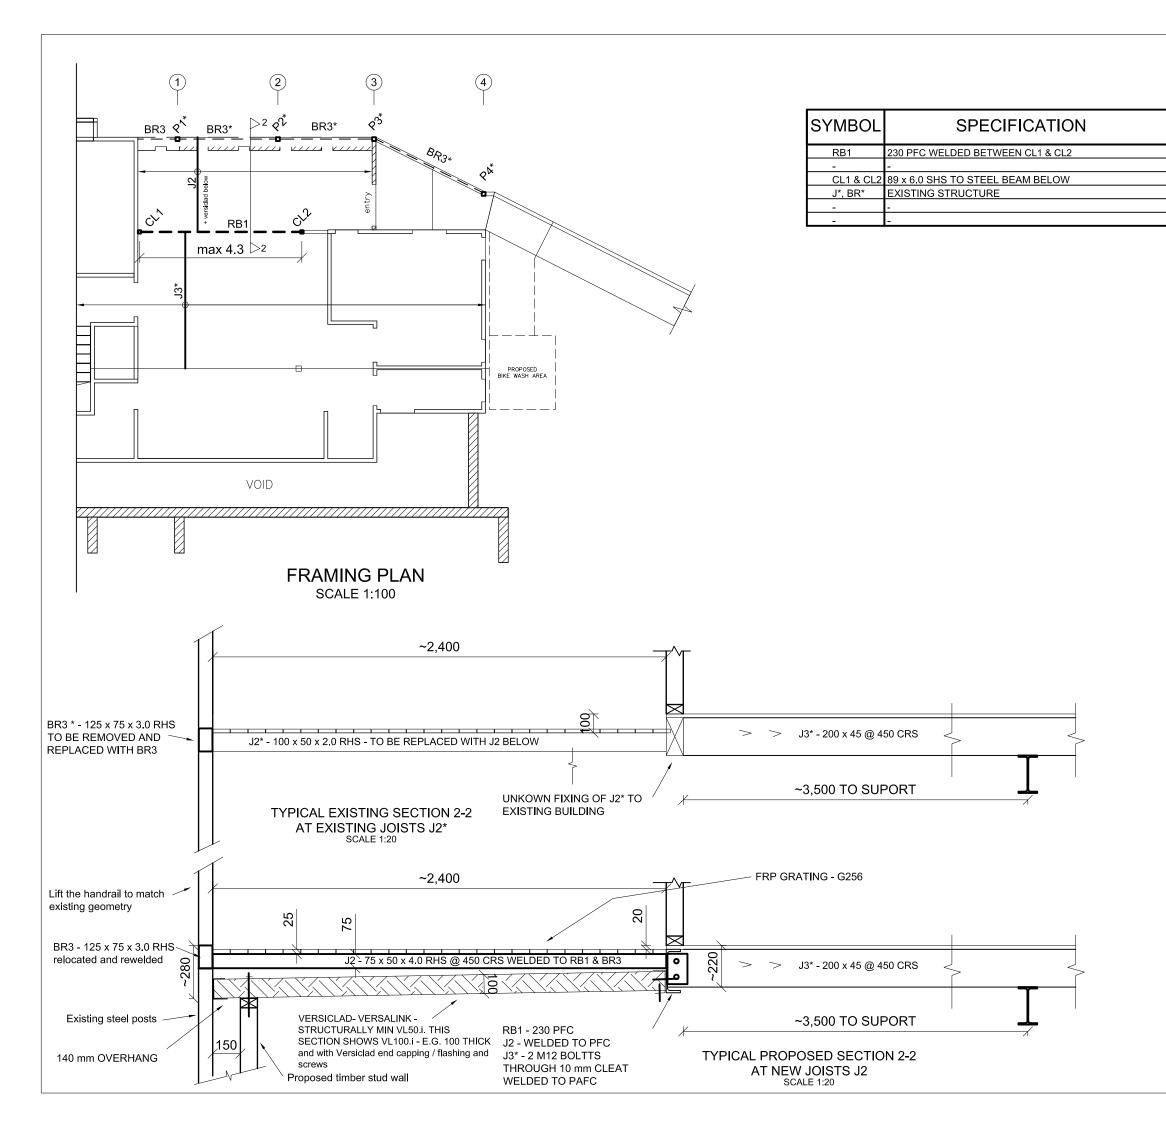

PRACTICAL ENGINEERING SOLUTIONS P/L

ABN 67 157 931 069
Structural &
Project Management ENGINEERS

46 Egan Street Cooma NSW 2630

M: 0402 15 22 16

office@practicalengineers.com.au

Drawing Name:

Proposed Alterations & Additions HI NOON SKI CLUB 12 BANJO DRIVE THREDBO NSW 2625

Client:

MAX SPAN

4.3 m

HI NOON SKI CLUB

Structural Sheet No. S05 of 6

Scale: Date:

1:20, 1:100 15.07.2024

Drawing No:

20230727A FRAMING PLAN


Sheet Size:

A3

Designed:
Drawn:
Checked:

O Boaru A Sferle O Boaru

Approved:

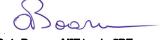


Ovi Boaru MIEAust CPEng

ISSUE DATE AMENDMENT INITIALS				
V1	08.08.24	FOOTPATH		ОВ

This document is Copyright and shall not be copied without written approval, nor shall it be used except for the Development and the Site Specified.

All workmanship and materials to conform with latest edition of the Building Code of Australia and relevant Australian Standards.

The contractor is to confirm all dimensions prior to commencing any works on site.

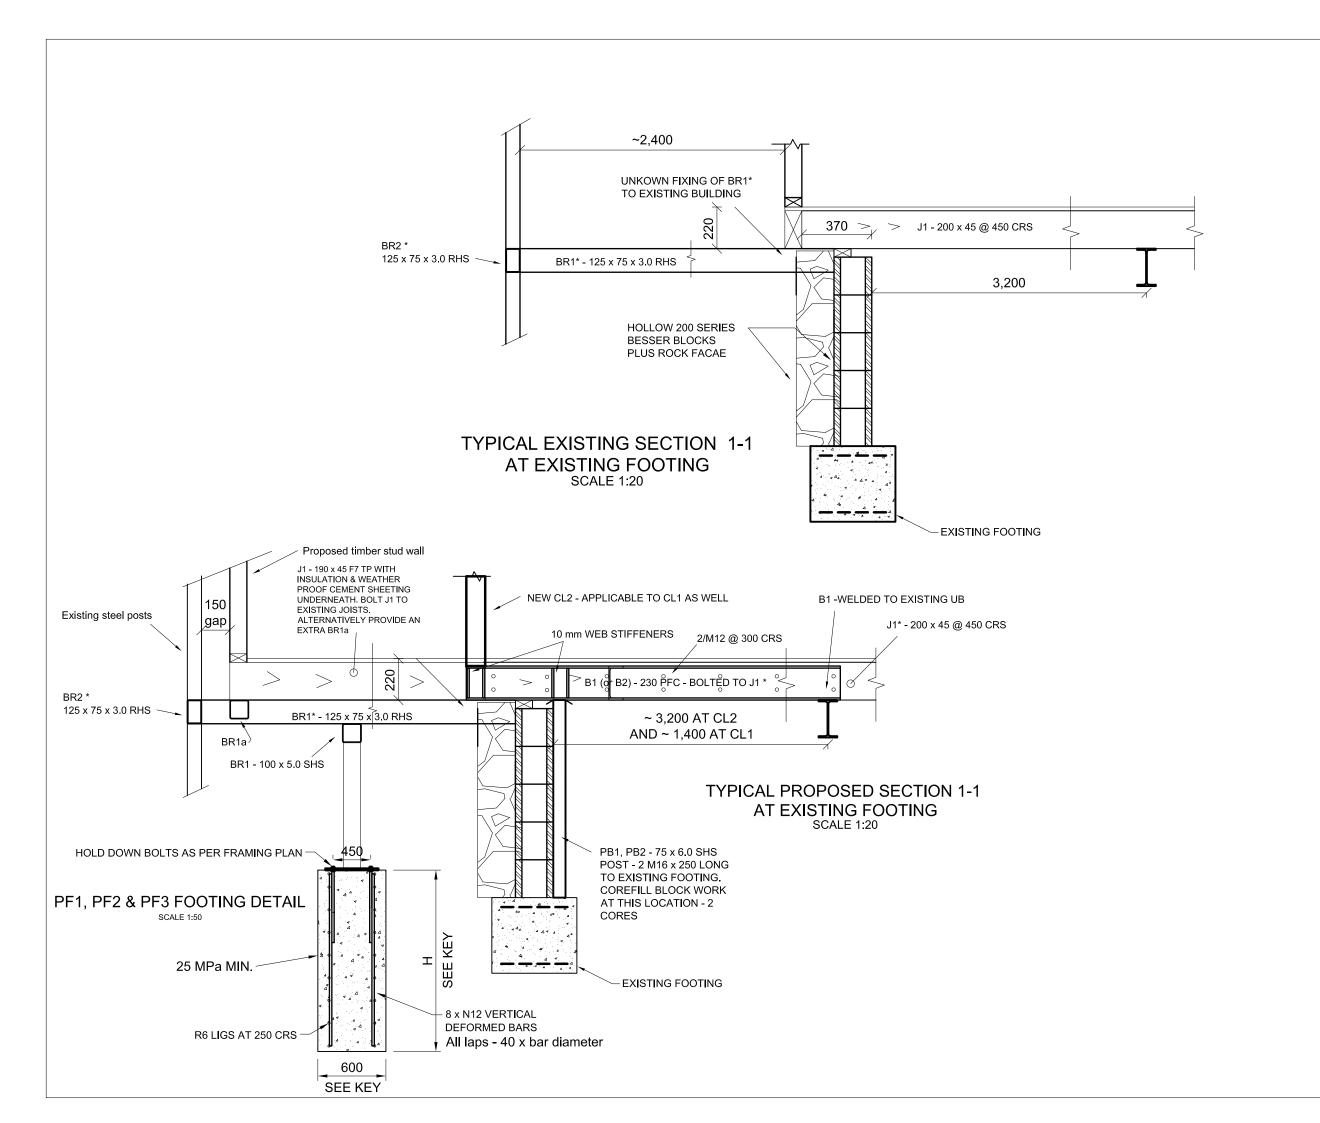

PRACTICAL ENGINEERING SOLUTIONS P/L

ABN 67 157 931 069 Structural & Project Management ENGINEERS

> 46 Egan Street Cooma NSW 2630

M: 0402 15 22 16

office@practicalengineers.com.au

Drawing Name:

Proposed Alterations & Additions HI NOON SKI CLUB 12 BANJO DRIVE THREDBO NSW 2625

Client:

HI NOON SKI CLUB

Structural Sheet No. S06 of 6

Scale:

Date:

1:20

15.07.2024 Drawing No: 20230727A

SECTIONS FLOOR

Sheet Size:

А3

Designed: Drawn:

O Boaru A Sferle

Checked: O Boaru

Approved:



Ovi Boaru MIEAust CPEng

ISSU	E DATE	AMENDMENT	INI	MALS
V1	08.08.24	FOOTPATH		ОВ

This document is Copyright and shall not be copied without written approval, nor shall it be used except for the Development and the Site Specified.

All workmanship and materials to conform with latest edition of the Building Code of Australia and relevant Australian Standards.

The contractor is to confirm all dimensions prior to commencing any works on site.